


**GUIDELINES FOR WIRE MANAGEMENT RACEWAYS AND CONDUITS:**

THE FOLLOWING GUIDELINES REGARDING WIRE MANAGEMENT RACEWAY AND CONDUIT STANDARDIZATION ARE TO BE FOLLOWED ON THIS PROJECT.

**CONDUIT DETAIL**  
LOCATED ON THE FLOOR PLAN ARE SYMBOLS FOR EACH CONDUIT ORIGINATION, DESTINATION AND SIZE. INCLUDED WITH EACH CONDUIT DETAIL IS A COMPILATION OF (5) PARTS.

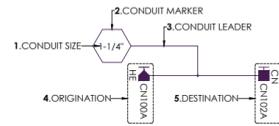


- 1. CONDUIT SIZE**  
THE CONDUIT SIZE INDICATES THE DIAMETER OF THE CONDUIT TO BE USED.
  - 2. CONDUIT MARKER**  
THE CONDUIT MARKER IS THE SYMBOL INDICATING THAT A CONDUIT IS PRESENT.
  - 3. CONDUIT LEADER**  
THE CONDUIT LEADER ATTACHES THE CONDUIT MARKER TO THE CONDUIT DESTINATION/ORIGINATION LINE.
  - 4. ORIGINATION**  
THE ORIGINATION SYMBOL INDICATES THE CONDUIT SYSTEM TYPE, ROOM NUMBER AND POSITION OF THE HEAD END. IN CASES WHERE A CONDUIT IS TERMINATED BETWEEN MULTIPLE FLOORS, AN ARROW WITH ROOM NUMBER WILL BE REPRESENTED IN PLACE OF THE ORIGINATION SYMBOL.
  - 5. DESTINATION**  
THE DESTINATION SYMBOL INDICATES THE CONDUIT SYSTEM TYPE, ROOM NUMBER AND POSITION OF THE CONDUIT END POINT.
- ORIGINATION POINT OF ALL CONDUITS**  
THE ORIGINATION POINT OF ALL CONDUITS WILL TYPICALLY INCLUDE THE DESIGNATION HE, IDF OR CPB (CONDUIT PULL BOX) SHOWN WITHIN THE DRAWINGS AND REFERENCED IN THE WIRE/CONDUIT SCHEDULE.
- DESTINATION POINT OF ALL CONDUITS**  
THE DESTINATION POINT OF ALL CONDUITS WILL BE SPECIFIED WITHIN THE WIRE/CONDUIT SCHEDULE.

**GUIDELINES FOR DEVICE DETAIL AND NUMBERING:**


THE FOLLOWING GUIDELINES REGARDING WIRE MANAGEMENT, NUMBERING METHODOLOGY AND CABLE SHEATHING COLOR STANDARDIZATION ARE TO BE FOLLOWED ON THIS PROJECT.

**DEVICE DETAIL**  
LOCATED ON THE FLOOR PLAN ARE SYMBOLS FOR EACH LOW VOLTAGE DEVICE. INCLUDED WITH EACH SYMBOL IS A COMPILATION OF (5) SPECIFIC ATTRIBUTES.

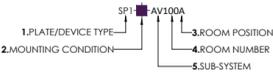

- 1. PLATE/DEVICE TYPE**  
THE PLATE OR DEVICE TYPE IS INDICATED BY 2 OR 3 ALPHA CHARACTERS WHICH REPRESENT THE DEVICE AT NOTED LOCATIONS (E.G. TV = TELEVISION, SP = SPEAKER, ETC.). THE NUMERIC CHARACTERS (E.G. 1, 2, 3, ETC.) FOLLOWING THE DEVICE TYPE REFERENCES THE SPECIFIC MANUFACTURE AND MODEL WITHIN THE DEVICE SCHEDULE.
- 2. MOUNTING CONDITION**  
THE MOUNTING CONDITION REFERENCES THE POSITION IN WHICH THE PLATE OR DEVICE WILL BE MOUNTED (E.G. IN-WALL, IN-CEILING, ETC.). EACH SYMBOL CAN BE FOUND ON THE SYMBOL SCHEDULE WHICH IS LOCATED ON THE "TITLE SHEET" OF EACH FLOOR PLAN PAGE WITHIN THE DRAWING PACKAGE.
- 3. SUB-SYSTEM**  
THE SUB-SYSTEM REFERENCE IDENTIFIES WHICH SUB-SYSTEM EACH SYMBOL IS ASSOCIATED WITH. (E.G. AV100A = AUDIO VIDEO)
- 4. ROOM NUMBER**  
THE ROOM NUMBER REFERENCE IDENTIFIES THE ROOM IN WHICH THE DEVICE RESIDES. (E.G. AV100A = ROOM NUMBER 100)
- 5. ROOM POSITION**  
THE ROOM POSITION REFERENCE IDENTIFIES THE UNIQUE LOCATION IN WHICH THE DEVICE IS LOCATED WITHIN A ROOM. (E.G. AV103A = LOCATION A)

**WIRE LABELING**  
ALL INTERCONNECTS AND WIRES ARE TO BE LABELED AT BOTH "ORIGIN" LOCATION AND "DESTINATION" LOCATION WITH THE APPROPRIATE NUMBER. WIRE NUMBERS CAN BE DERIVED FROM THE WIRE/CONDUIT SCHEDULES. USING THE "WIRE ID" COLUMN, EACH WIRE IS LISTED WITH AN ASSOCIATED ALPHANUMERIC NUMBER (E.G. AV103A, SP1).

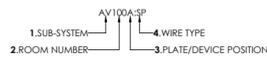

THIS DESIGNATION SHALL BE MARKED ON THE WIRE USING A PANDUIT OR SIMILAR LABEL MAKER. THE METHODOLOGY OF WIRE NUMBERING IS AS FOLLOWS:

- THE LEADING LETTERS OF A WIRE NUMBER REFER TO THE SUB-SYSTEM. THE SUB-SYSTEM REFERENCE IDENTIFIES WHICH SUB-SYSTEM EACH SYMBOL IS ASSOCIATED WITH. (E.G. AV100A = AUDIO VIDEO)
- THE NUMBER FOLLOWING THE SUB-SYSTEM REFERS TO THE ROOM NUMBER. THE ROOM NUMBER REFERENCE IDENTIFIES THE ROOM IN WHICH THE DEVICE RESIDES. (E.G. AV100A = ROOM NUMBER 100)
- THE LETTER FOLLOWING THE ROOM NUMBER REFERS TO THE ROOM POSITION. THE ROOM POSITION REFERENCE IDENTIFIES THE UNIQUE LOCATION IN WHICH THE DEVICE IS LOCATED WITHIN A ROOM. (E.G. AV103A = LOCATION A)
- THE LETTERS FOLLOWING THE UNIQUE LOCATION IDENTIFIER REFER TO THE GENERAL WIRE TYPE. (E.G. AV100A, SP1 = SPEAKER WIRE)

IN SOME CASES MULTIPLE CABLES OF THE SAME TYPE WILL BE RUN TO THE SAME LOCATION. IN THESE INSTANCES A NUMBER IS ATTACHED AT THE END OF THE "WIRE ID". (E.G. AV100A, SP1 AND AV100A, SP2). A "WIRE STANDARDS" SPECIFICATION IS ATTACHED TO THE "WIRE/CONDUIT SCHEDULES". THE "WIRE STANDARDS" DOCUMENT WILL CALL OUT WIRE COMPOSITION AND SPECIFY WHICH MANUFACTURERS PRODUCT WILL BE AUTHORIZED FOR INSTALLATION.

**ORIGINATION POINT OF ALL WIRES**  
THE ORIGINATION POINT OF ALL WIRES WILL TYPICALLY INCLUDE THE DESIGNATION HE, AV OR IDF SHOWN WITHIN THE DRAWINGS AND REFERENCED IN THE WIRE/CONDUIT SCHEDULE.


**DESTINATION POINT OF ALL WIRES**  
THE DESTINATION POINT OF ALL WIRES WILL BE SPECIFIED WITHIN THE WIRE/CONDUIT SCHEDULE.

**WIRE SCHEDULE**

WIRE ID	WIRE DESCRIPTION	WIRE APPLICATION	DEVICE TYPE	ORIGIN NAME	HEAD END LOCATION	ORIGIN POSITION	DESTINATION NAME	DESTINATION LOCATION	DESTINATION POSITION	NOTES	
1	AV104D,SP1	14/2 Speaker Cable	Speaker Connection to Amplifier	A/V	TV LOUNGE	104AV	AV104A	TV LOUNGE	104	AV104D	SPLIT TO INDIVIDUAL RUNS
2	AV104D,SP2	14/2 Speaker Cable	Speaker Connection to Amplifier	A/V	TV LOUNGE	104AV	AV104A	TV LOUNGE	104	AV104D	SPLIT TO INDIVIDUAL RUNS
3	AV104D,SP3	14/2 Speaker Cable	Speaker Connection to Amplifier	A/V	TV LOUNGE	104AV	AV104A	TV LOUNGE	104	AV104D	SPLIT TO INDIVIDUAL RUNS
4	AV104E, SUB	14/2 Speaker Cable	Subwoofer Connection to Amplifier	A/V	TV LOUNGE	104AV	AV104A	TV LOUNGE	104	AV104E	
5	AV104F, SP	14/2 Speaker Cable	Speaker Connection to Amplifier	A/V	TV LOUNGE	104AV	AV104A	TV LOUNGE	104	AV104F	
6	AV104G, SP	14/2 Speaker Cable	Speaker Connection to Amplifier	A/V	TV LOUNGE	104AV	AV104A	TV LOUNGE	104	AV104G	

**WIRE TYPE STANDARD**

SUFFIX	WIRE DESCRIPTION	WIRE APPLICATION	DEVICE TYPE	MANUFACTURER	MODEL	COLOR	NOTES
KSU	Cat6 4-pr Cable	Telephone System Voice Extension	VOICE	BELDEN	2413	BLUE	Plenum Rated
LAN	Cat6 4-pr Cable	Local Area Network	DATA	BELDEN	2413	GREEN	Plenum Rated
UTP	Cat6 4-pr Cable	Data/Video	A/V	BELDEN	2413	YELLOW	Plenum Rated
SPARE	Cat6 4-pr Cable	Spare	A/V	BELDEN	2413	ORANGE	Plenum Rated
CX	RG6 Quad Shielded Coaxial Cable	Television Video/Audio/CATV/Satellite Service	A/V	BELDEN	7914P	WHITE	Plenum Rated

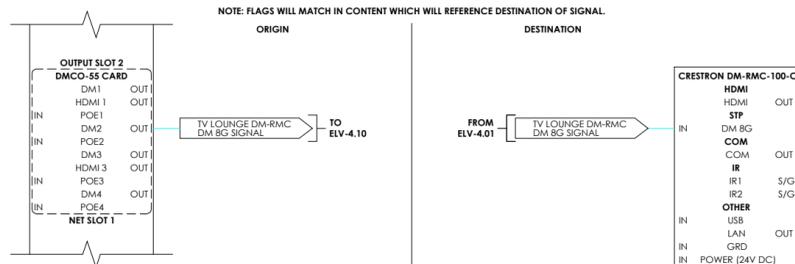

**GENERAL DETAILS**

- AV VIDEO/AUDIO HEAD END
- TV TELEVISION OUTLET
- TV TELEVISION FLOOR OUTLET
- TV TELEVISION OUTLET IN-CEILING
- AV AUDIO/VIDEO OUTLET
- SP SPEAKER IN-CEILING
- SP SPEAKER IN-WALL
- SJ SPEAKER JACK OUTLET
- SUB SUBWOOFER UNDER FLOOR
- SUB SUBWOOFER IN-WALL
- SUB SUBWOOFER IN ROOM/IN LANDSCAPE
- VC VOLUME CONTROL
- PJ PROJECTOR OUTLET IN-CEILING
- CATV CATV HEAD END
- SAT SAT ANTENNA
- CN CONDUIT OUTLET
- ART MOTORIZED CANVAS
- IDF AUDIO/VIDEO INTERMEDIATE DISTRIBUTION FRAME
- AVS DEDICATED CIRCUIT (TO DEDICATED A/V SUB PANEL)

**ENTERTAINMENT SYMBOLS**

- OC OVERLAY CONTROL HEAD END
- OC OVERLAY CONTROL DEVICE
- TP TOUCH PANEL IN-WALL
- TP WIRELESS TOUCH PANEL
- TS TEMPERATURE SENSOR


**OVERLAY CONTROL SYMBOLS**

- COM COMMUNICATIONS HEAD END
- COM COMMUNICATIONS CONNECTION
- COM COMMUNICATIONS - FLOOR MOUNTED
- DP DOORPHONE
- WAP WIRELESS ACCESS POINT
- WFI DISTRIBUTED ANTENNA SYSTEM - WIFI
- CEL DISTRIBUTED ANTENNA SYSTEM - CELLULAR
- IDF COMMUNICATIONS INTERMEDIATE DISTRIBUTION FRAME

**COMMUNICATION SYMBOLS**

- SEC SECURITY SYSTEM HEAD END
- SK SECURITY KEYPAD
- DS DOOR CONTACT
- WS WINDOW CONTACT
- AS ALARM SCREEN
- MD MOTION DETECTOR - CEILING MOUNTED
- MD MOTION DETECTOR - WALL MOUNTED
- AD AUDIBLE DEVICE
- GB GLASS BREAK DETECTOR
- SS SHOCK SENSOR
- SD SMOKE DETECTOR
- HD HEAT DETECTOR
- CO CARBON MONOXIDE SENSOR - CEILING MOUNTED
- CO CARBON MONOXIDE SENSOR - WALL MOUNTED
- SL SECURITY LIGHTING
- DR DOOR RELEASE - CEILING MOUNTED
- DR DOOR RELEASE - WALL MOUNTED
- AC ACCESS CONTROL KEYPAD
- RTE RELEASE TO EXIT BUTTON
- CC SURVEILLANCE CAMERA - CEILING MOUNTED
- CC SURVEILLANCE CAMERA - WALL MOUNTED
- FL FLOOD SENSOR
- PB PANIC BUTTON
- PB PANIC BUTTON (WIRED THROUGH FLOOR BOX)
- IS INTERCOM STATION
- CN CONDUIT OUTLET
- TV SECURITY MONITOR
- IDF SECURITY INTERMEDIATE DISTRIBUTION FRAME
- CN CONDUIT END POINT
- CPB CONDUIT PULL BOX

**SECURITY/FIRE SYMBOLS**

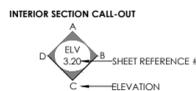

**ARCHITECTURAL SYMBOL SCHEDULE**

- AC ACCESS CONTROL
- ACE ACCESS CONTROL (EXTERIOR RUNS)
- ACS ACCESS CONTROL SYSTEM
- AD AUDIBLE DEVICE
- ART ARTWORK (MOTORIZED CANVAS)
- AS ALARM SCREEN
- AV AUDIO/VIDEO
- AVS AUDIO/VIDEO SYSTEM
- BD BUS DEVICE
- CATV CABLE TELEVISION
- CC CLOSED CIRCUIT CAMERA
- CCE CLOSED CIRCUIT CAMERA (EXTERIOR RUNS)
- CCTV CLOSED CIRCUIT TELEVISION
- CEL CELLULAR
- CN CONDUIT
- CO CARBON MONOXIDE
- CON CONCEPTUAL (DRAWING SET)
- COM COMMUNICATIONS
- CPB CONDUIT PULL BOX
- CTA CATEGORY CABLE - AUDIO
- CTV CATEGORY CABLE - VIDEO
- CX COAXIAL
- CXE COAXIAL (EXTERIOR RUNS)
- DP DOOR PHONE
- DPE DOOR PHONE (EXTERIOR RUNS)
- DR DOOR RELEASE
- DRE DOOR RELEASE (EXTERIOR RUNS)
- DS DOOR SENSOR
- DSE DOOR SENSOR (EXTERIOR RUNS)
- ELV ELECTRONIC LOW VOLTAGE (DRAWING SET)
- FL FLOOD SENSOR
- FO FIBER OPTIC
- GB GLASS BREAK
- HD HEAT DETECTOR
- HE HEAD END
- HVAC HEATING, VENTILATION AND AIR COOLING
- IDF INTERMEDIATE DISTRIBUTION FRAME
- IS INTERCOM STATION
- KSU KEY SYSTEM UNIT
- LAN LOCAL AREA NETWORK
- LANE LOCAL AREA NETWORK (EXTERIOR RUNS)
- LC LIFT CONTROL
- LL LINE LEVEL
- MD MOTION DETECTOR
- MDE MOTION DETECTOR (EXTERIOR RUNS)
- MDF MAIN DISTRIBUTION FRAME
- MS MOISTURE SENSOR
- OC OVERLAY CONTROL
- OCS OVERLAY CONTROL SYSTEM
- PB PANIC BUTTON
- PH PHONE
- PJ PROJECTOR
- RN REMOTE NODE
- RP REMOTE POWER
- RPE REMOTE POWER (EXTERIOR RUNS)
- RTE REQUEST TO EXIT
- RTEE REQUEST TO EXIT (EXTERIOR RUNS)
- SAT SATELLITE TELEVISION
- SEC SECURITY SYSTEM
- SD SMOKE DETECTOR
- SJ SPEAKER JACK
- SK SECURITY KEYPAD
- SL SECURITY LIGHTING
- SP SPEAKER
- SPE SPEAKER (EXTERIOR RUNS)
- SS SHOCK SENSOR
- SUB SUBWOOFER
- TH THERMOSTAT
- TN THERMOSTAT NETWORK
- TP TOUCH PANEL
- TS TEMPERATURE SENSOR
- TV TELEVISION
- UTP UNSHIELDED TWISTED PAIR
- VC VOLUME CONTROL
- WAP WIRELESS ACCESS POINT
- WHA WHOLE HOUSE AUDIO
- WHV WHOLE HOUSE VIDEO
- WFI WI-FI
- WS WINDOW SENSOR

**ABBREVIATIONS**

- BLOCK DIAGRAM SIGNAL LINE TYPES**
- AUDIO
  - VIDEO
  - DIGITAL AUDIO
  - OVERLAY CONTROL
  - LAN
  - POWER

**SIGNAL LINE TYPES**

- ELV-1.00 TITLE SHEET
- CON-2.10H CONCEPTUAL LAYOUT PLAN FIRST FLOOR AUDIO VIDEO
- CON-2.10S CONCEPTUAL LAYOUT PLAN FIRST FLOOR SECURITY
- CON-2.11H CONCEPTUAL LAYOUT PLAN FIRST FLOOR WI-FI
- ELV-2.10H GENERAL DEVICE LAYOUT PLAN FIRST FLOOR AUDIO VIDEO
- ELV-2.10S GENERAL DEVICE LAYOUT PLAN FIRST FLOOR SECURITY
- ELV-2.10CN CONDUIT LAYOUT PLAN FIRST FLOOR COMPOSITE
- ELV-2.80 WIRE INFRASTRUCTURE SCHEDULE 1
- ELV-2.81 WIRE INFRASTRUCTURE SCHEDULE 2
- ELV-3.13 LIVING ROOM 107 COORDINATED DEVICE DRAWINGS
- ELV-3.14 DINING ROOM 108 COORDINATED DEVICE DRAWINGS
- ELV-3.15 FAMILY ROOM 111 AND LIVING DECK 002 COORDINATED DEVICE DRAWINGS
- ELV-3.50 CONCEPTUAL LAYOUT PLAN MAIN DISTRIBUTION FRAME
- ELV-3.60 MAIN DISTRIBUTION FRAME DEVICE PLACEMENT ELEVATIONS
- ELV-3.61 MAIN DISTRIBUTION FRAME RACK ELEVATIONS 1
- ELV-3.62 MAIN DISTRIBUTION FRAME RACK ELEVATIONS 2
- ELV-3.70 MAIN DISTRIBUTION FRAME RACK 1 DEMARCATION
- ELV-3.80 MAIN DISTRIBUTION FRAME CONDUIT PLACEMENT ELEVATION
- ELV-4.00 AUDIO VIDEO DISTRIBUTION BLOCK DIAGRAM 1
- ELV-4.01 AUDIO VIDEO DISTRIBUTION BLOCK DIAGRAM 2
- ELV-4.05 CCTV DISTRIBUTION BLOCK DIAGRAM
- ELV-4.10 BEDROOM 106, DINING ROOM 108, AND FAMILY ROOM 111 BLOCK DIAGRAMS
- ELV-4.11 MEDIA ROOM BLOCK DIAGRAM
- ELV-4.20 OVERLAY CONTROL BLOCK DIAGRAM
- ELV-5.00 DEVICE SCHEDULE
- ELV-6.00 PLATE DETAILS 1
- ELV-6.01 PLATE DETAILS 2
- ELV-6.10 INSTALLATION DETAILS

**SHEET INDEX**

**DRAWINGS INCLUDED WITHIN SPECIFICATION:**  
THERE ARE AN EXTENSIVE COLLECTION OF DRAWINGS PROVIDED WITH EACH SYSTEM SPECIFICATION. THESE DRAWINGS ARE ORGANIZED FUNCTIONALLY IN ACCORDANCE WITH THE FOLLOWING OUTLINE:

- ELV-1.00 TITLE SHEET**  
THIS COVER PAGE CONTAINS THE TITLE BLOCK, PROJECT INFORMATION AND A DETAILED LISTING OF ALL NOTES AND SYMBOL DEFINITIONS USED THROUGHOUT THE PROJECT.
- ELV-2.NN FLOORPLANS**  
THESE SERIES OF DRAWINGS ARE ORGANIZED BY LEVEL, PRESENTING THE LOCATIONS OF DEVICES, PRODUCT CALLOUTS AND CONSTRUCTION NOTES WITHIN THE FLOORPLANS.
- ELV-3.NN DEVICE PLACEMENT ELEVATIONS AND SECTIONS**  
THESE SERIES OF DRAWINGS ARE ORGANIZED BY LEVEL, PRESENTING ROOM DETAILS WITHIN THE REFLECTED CEILING PLAN AND ELEVATIONS WITH DEVICES, ROOM PLATE DETAILS, HEAD END WIRING CABINETS AND DEMARCATION PANELS, ETC.
- ELV-4.NN BLOCK DIAGRAMS**  
THESE SERIES OF DRAWINGS ARE ORGANIZED BY SYSTEM AND AREA TO PRESENT THE PHYSICAL CONNECTIVITY OF EACH SYSTEM.
- ELV-5.NN DEVICE SCHEDULES**  
THESE SERIES OF DRAWINGS SUPPLY THE PRODUCT SPECIFIED AND CABLING ALLOWED.

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SHEET NAME:  
TITLE SHEET

REVISIONS	BY

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SCALE: N.T.S.  
DESIGNER: DESIGNER  
DRAWN: DRAWNBY  
SHEET:

**DRAWING DESCRIPTIONS**


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PLEASANTON, CA 94588

SHEET NAME:  
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FIRST FLOOR AUDIO VIDEO

REVISIONS	BY


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DESIGNER: DESIGNER  
DRAWN: DRAWNBY  
SHEET:

**CON-2.10H**

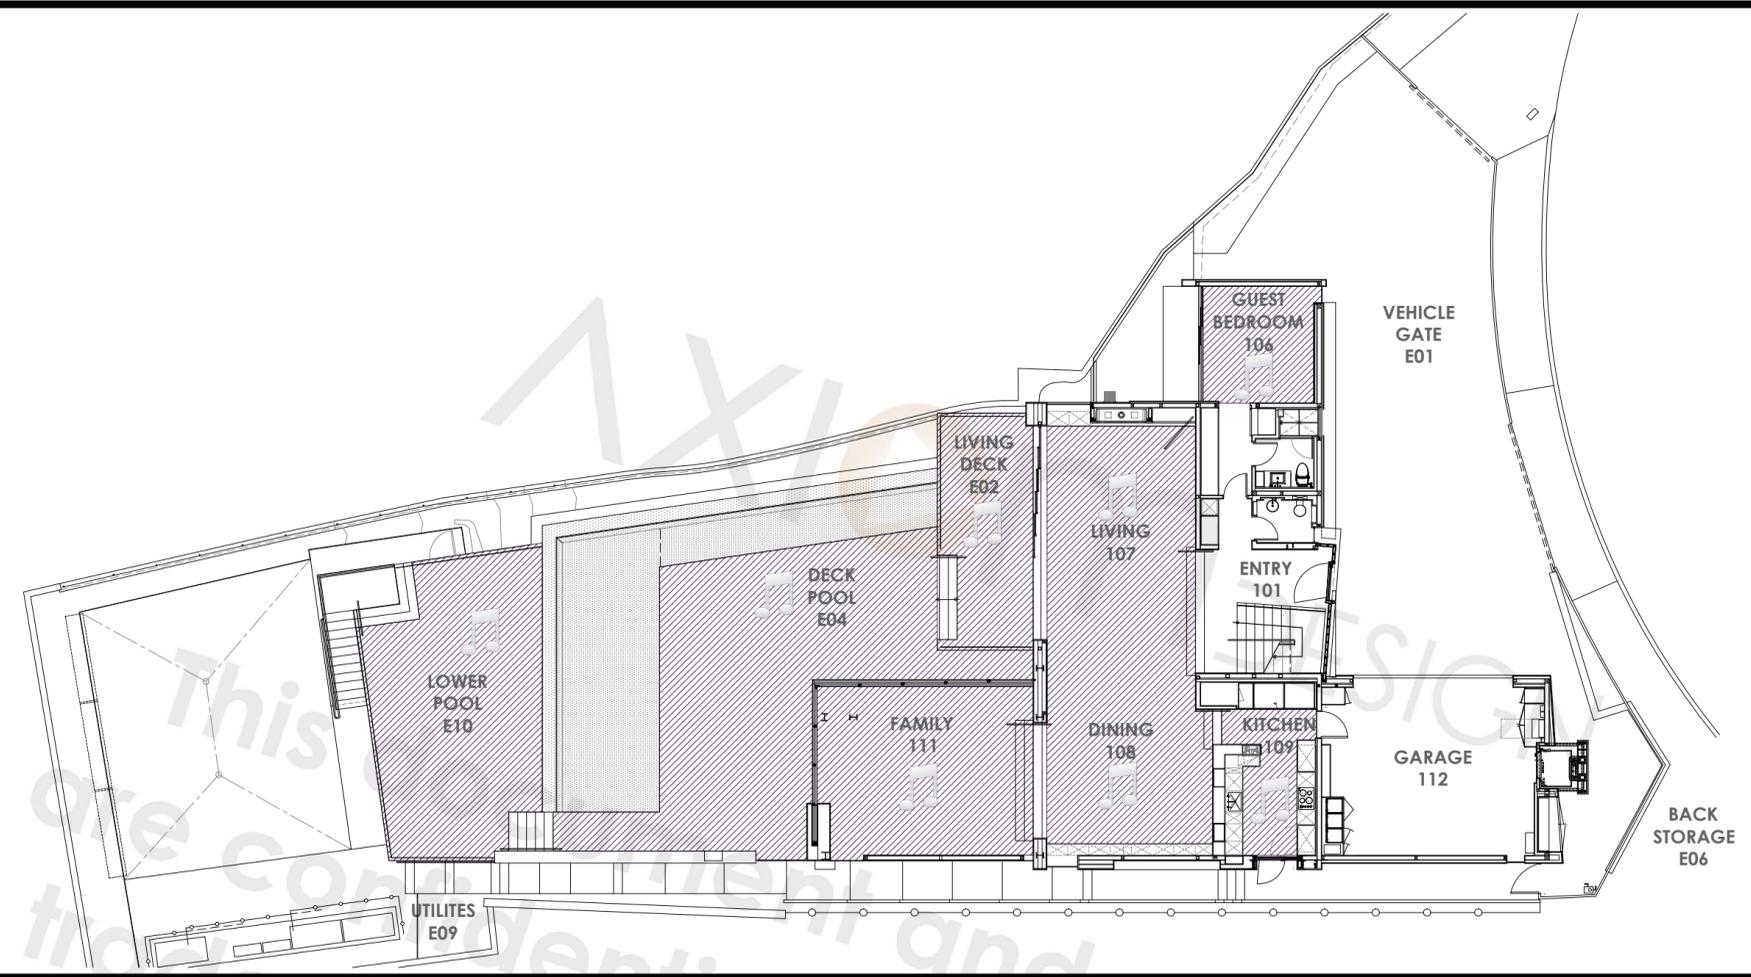

A FIRST FLOOR DISTRIBUTED AUDIO COVERAGE

SCALE: 1/8"=1'-0"

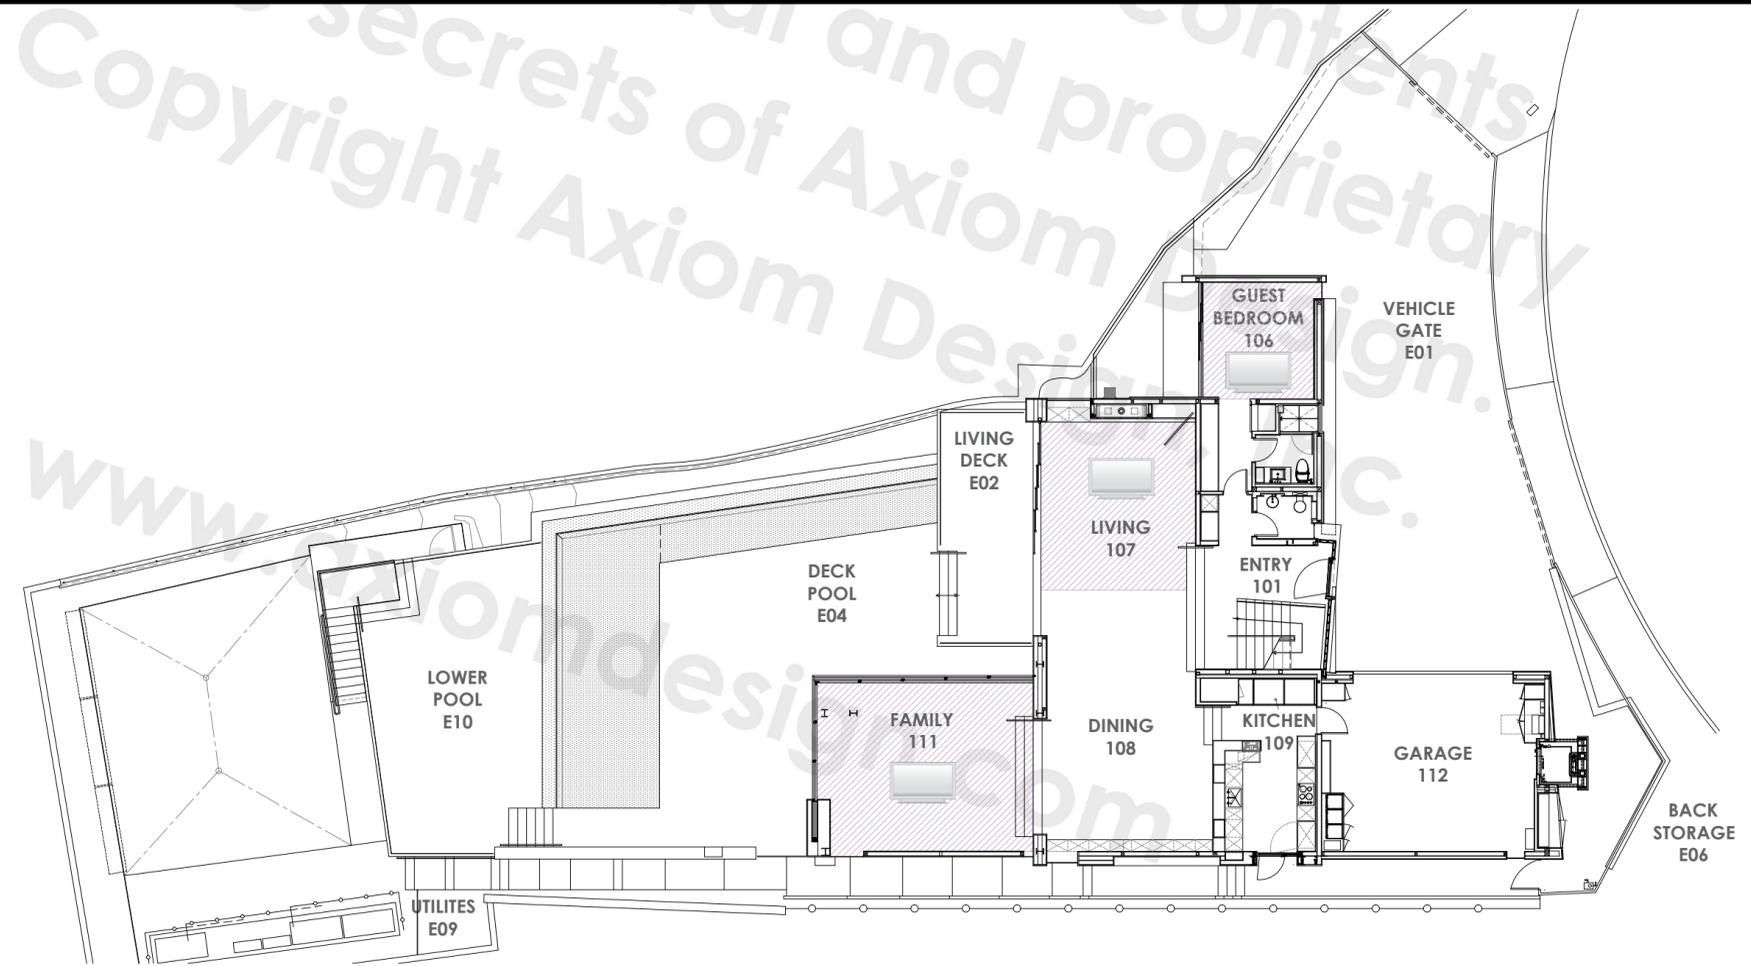

B FIRST FLOOR DISTRIBUTED VIDEO COVERAGE


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SHEET NAME:  
CONCEPTUAL LAYOUT PLAN  
FIRST FLOOR SECURITY

REVISIONS	BY


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SHEET:

**CON-2.10S**

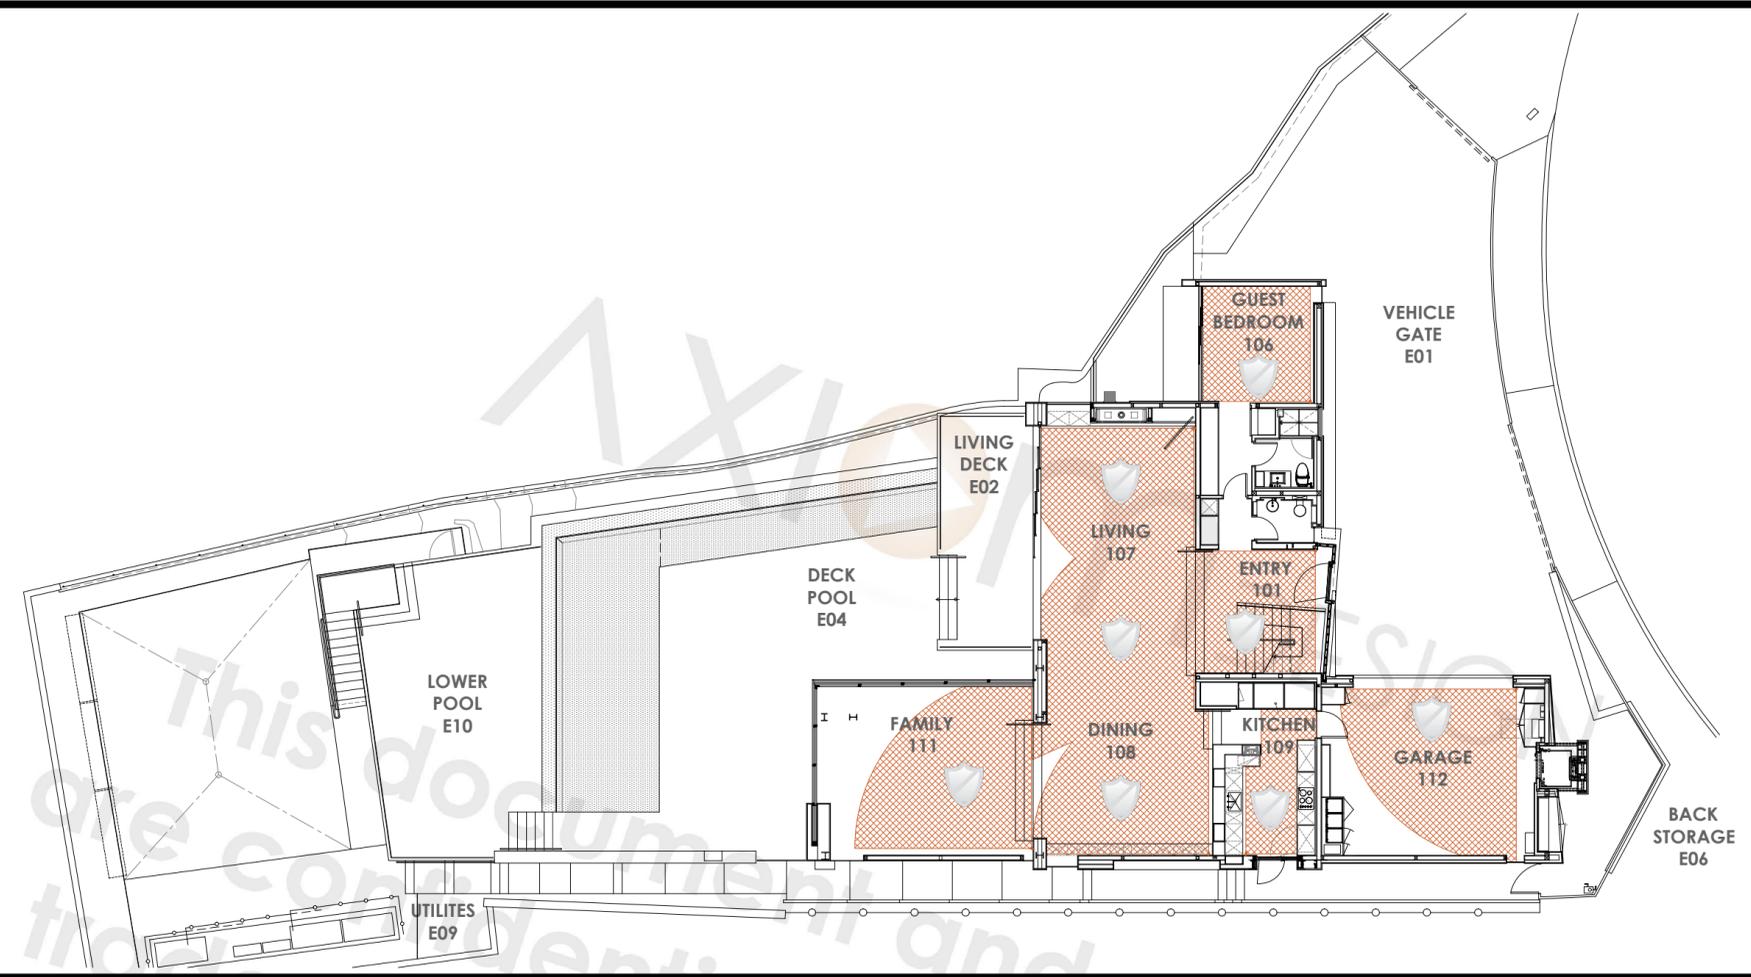

A FIRST FLOOR MOTION DETECTOR COVERAGE

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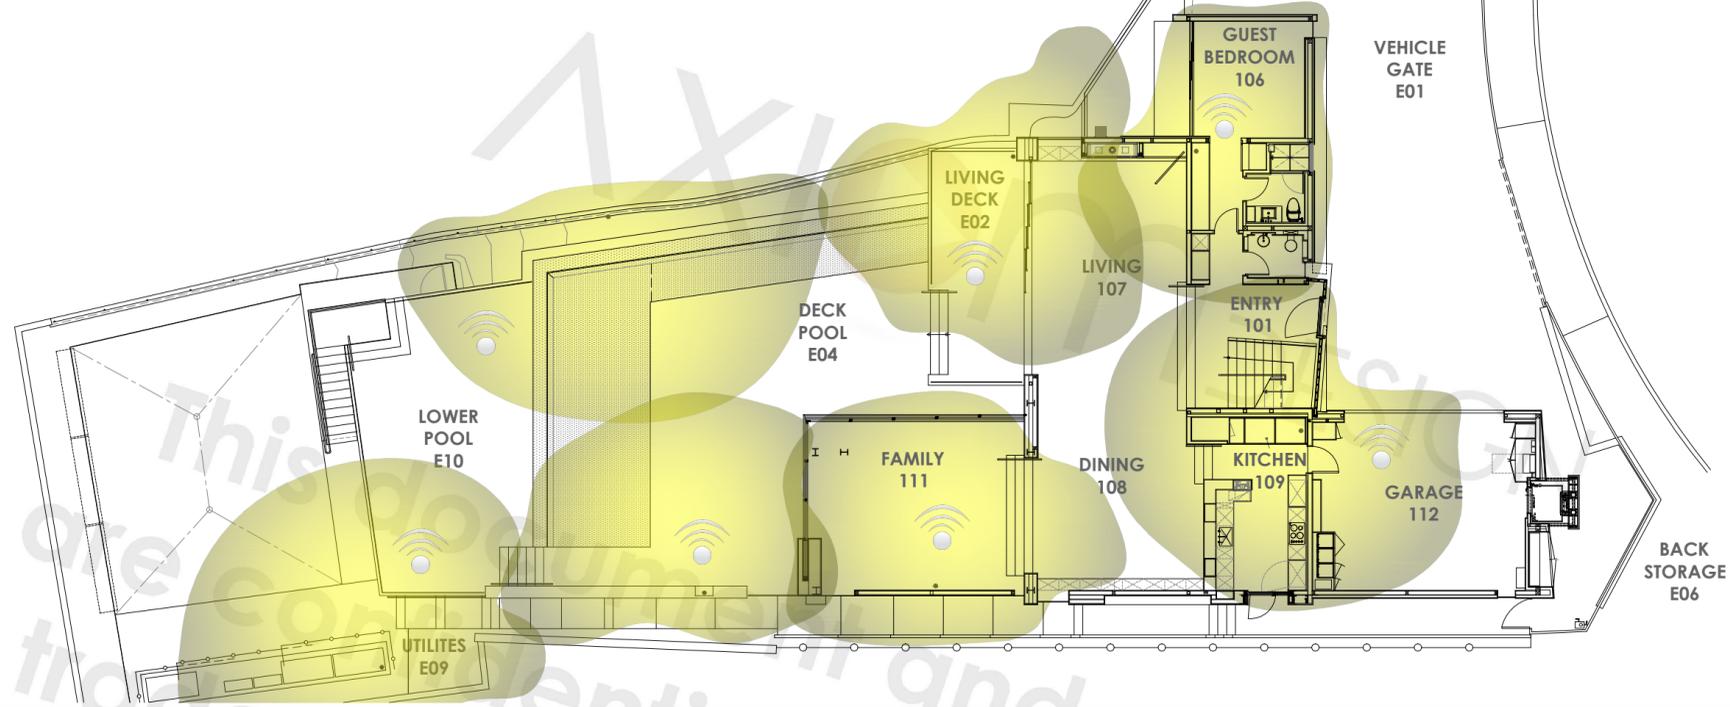


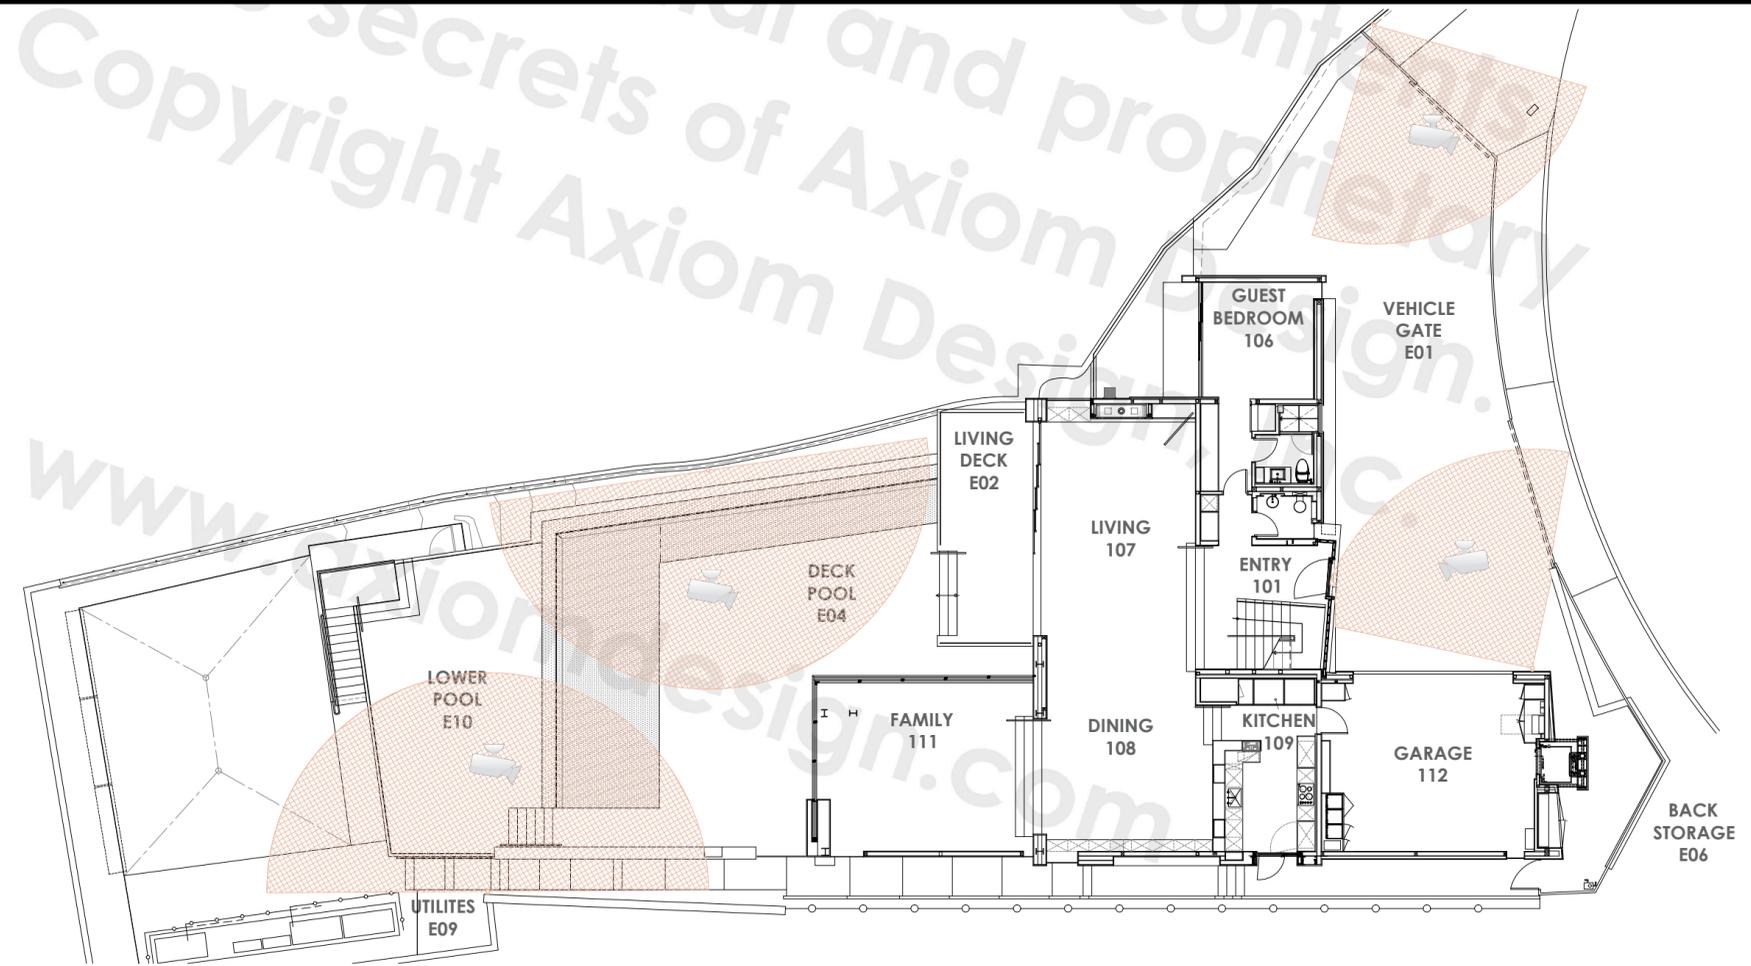B FIRST FLOOR SURVEILLANCE COVERAGE

SCALE: 1/8"=1'-0"



WI-FI  
COVERAGE



A FIRST FLOOR WIFI COVERAGE

SCALE: 1/8"=1'-0"

**SAMPLE PROJECT**

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SHEET NAME:  
CONCEPTUAL LAYOUT PLAN  
FIRST FLOOR WI-FI

REVISIONS	BY

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 SCALE: AS NOTED  
 DESIGNER: DESIGNER  
 DRAWN: DRAWNBY  
 SHEET:

CON-2.11H


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PLEASANTON, CA 94588

SHEET NAME:  
GENERAL DEVICE LAYOUT PLAN  
FIRST FLOOR AUDIO VIDEO

REVISIONS	BY

DATE: 00-00-00  
SCALE: 1/4"=1'-0"  
DESIGNER: DESIGNER  
DRAWN: DRAWNBY  
SHEET:

**ELV-2.10H**

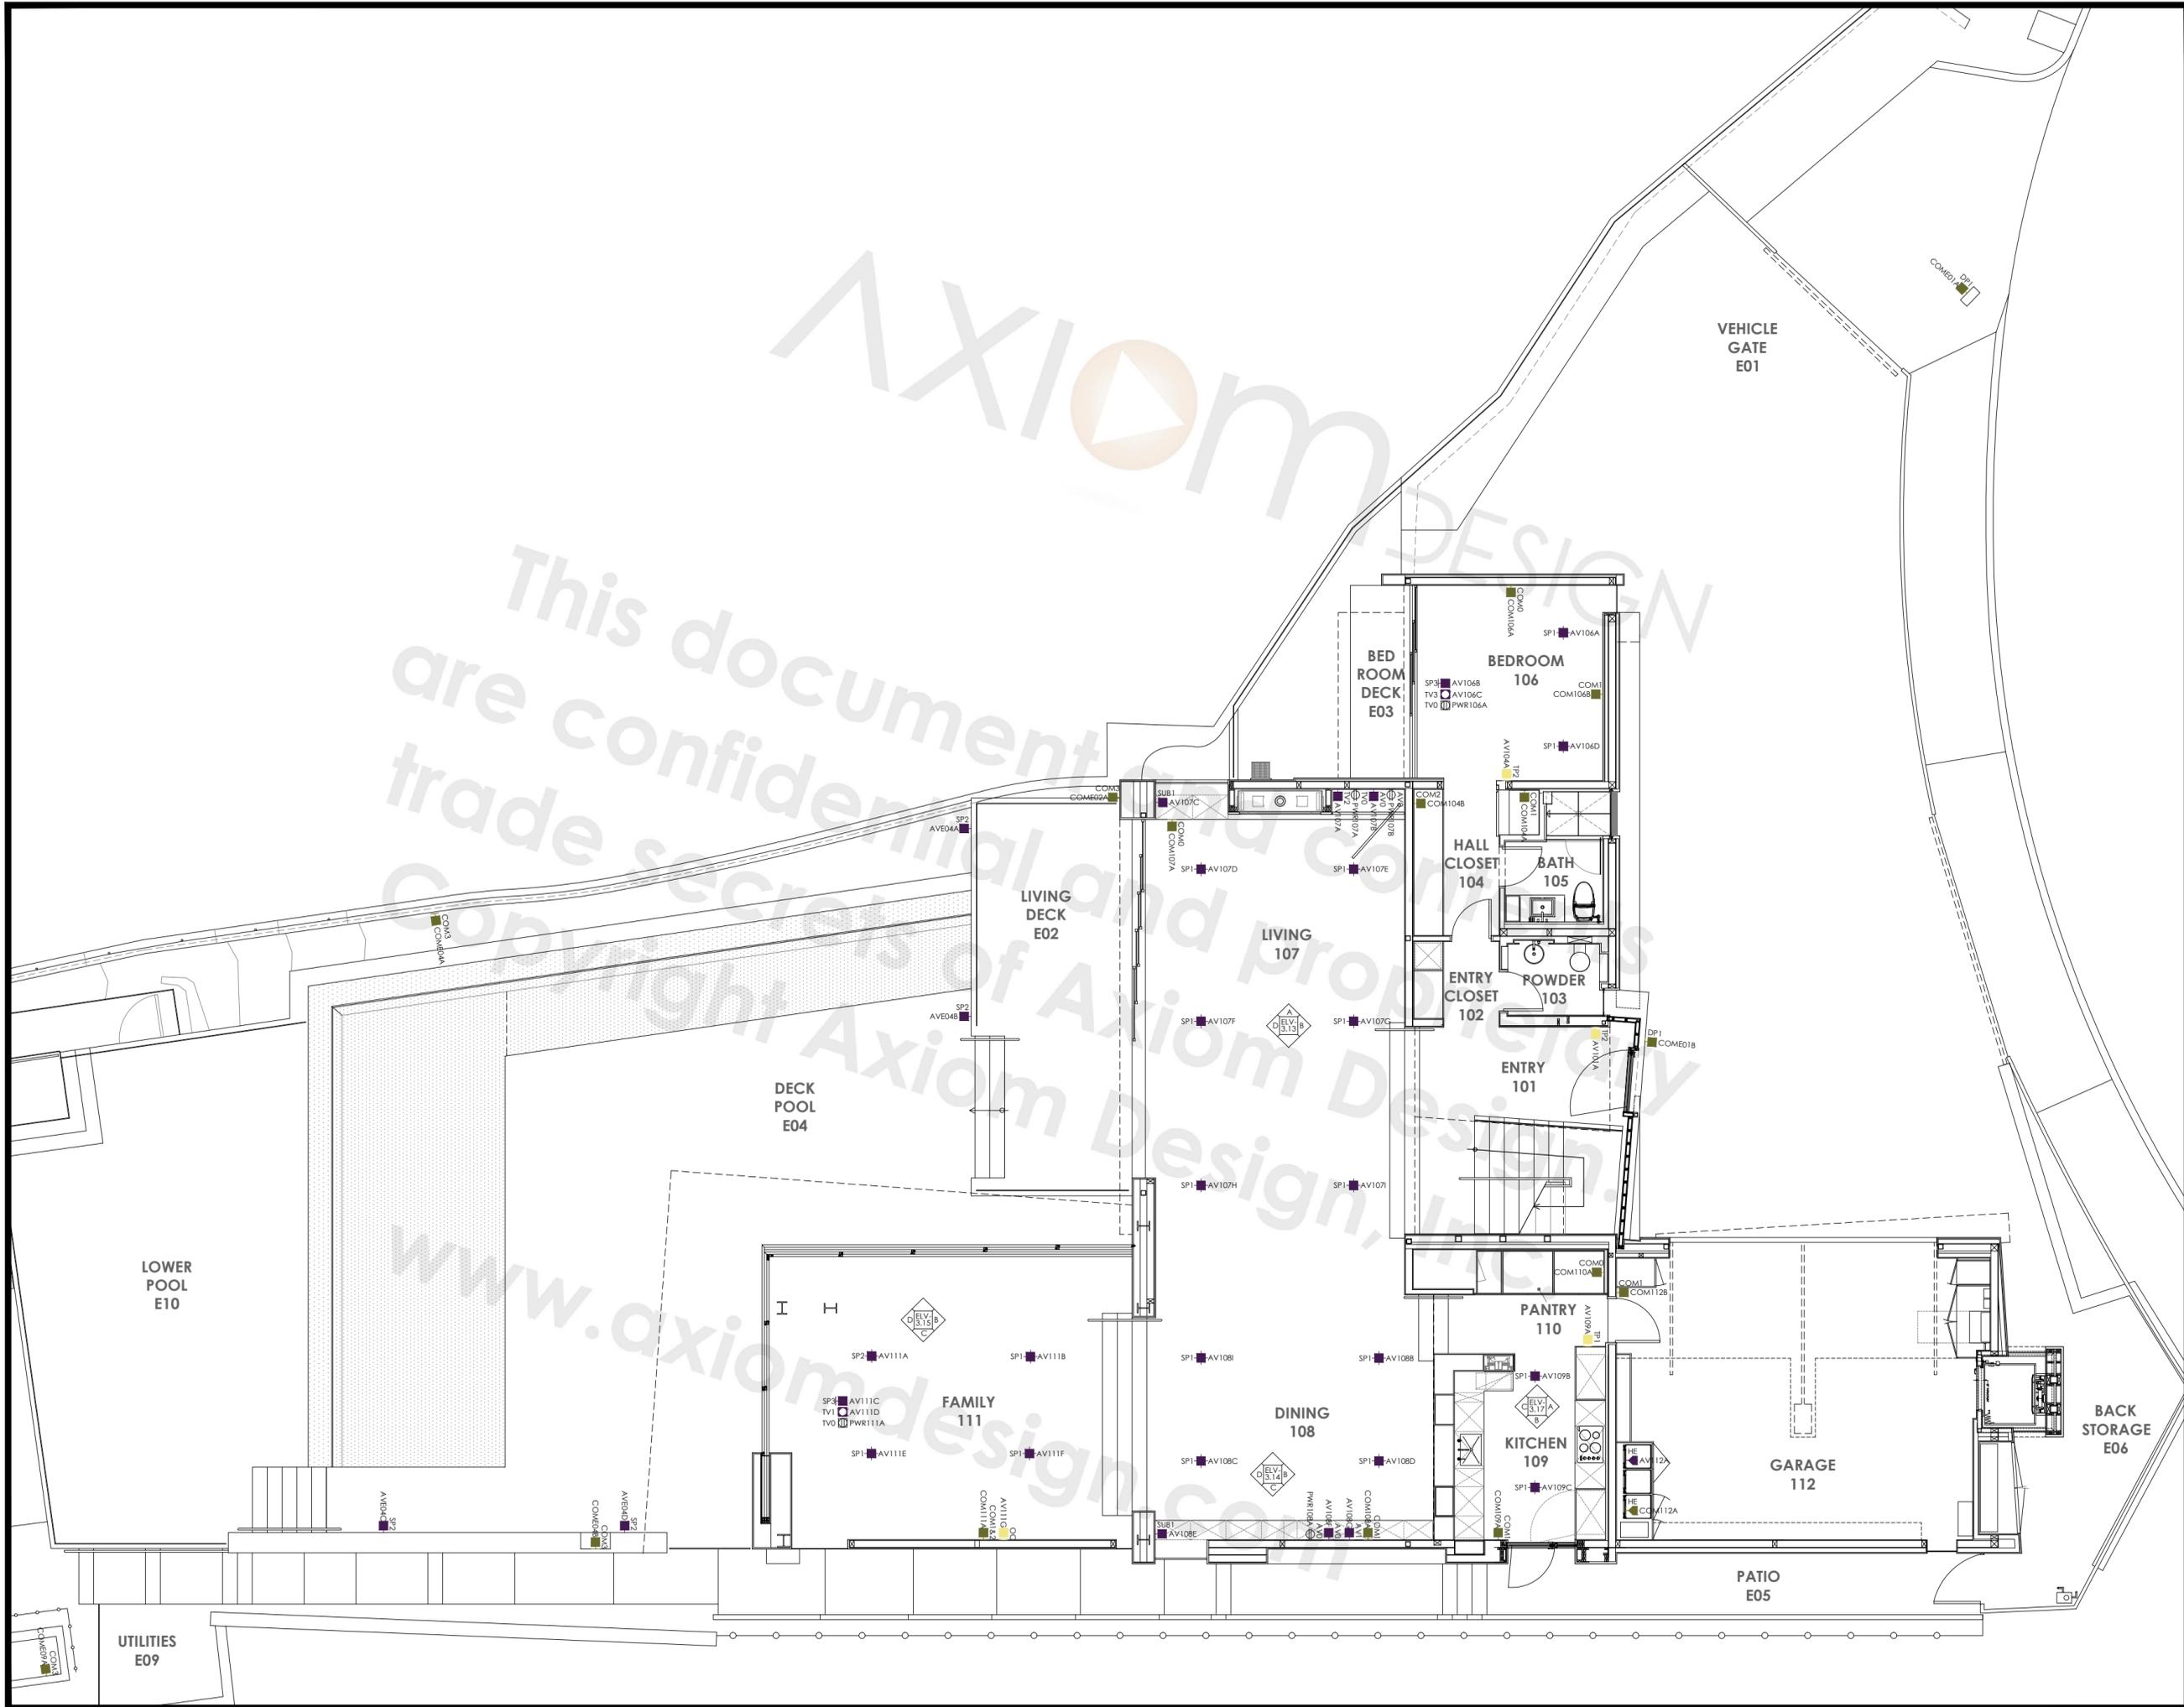

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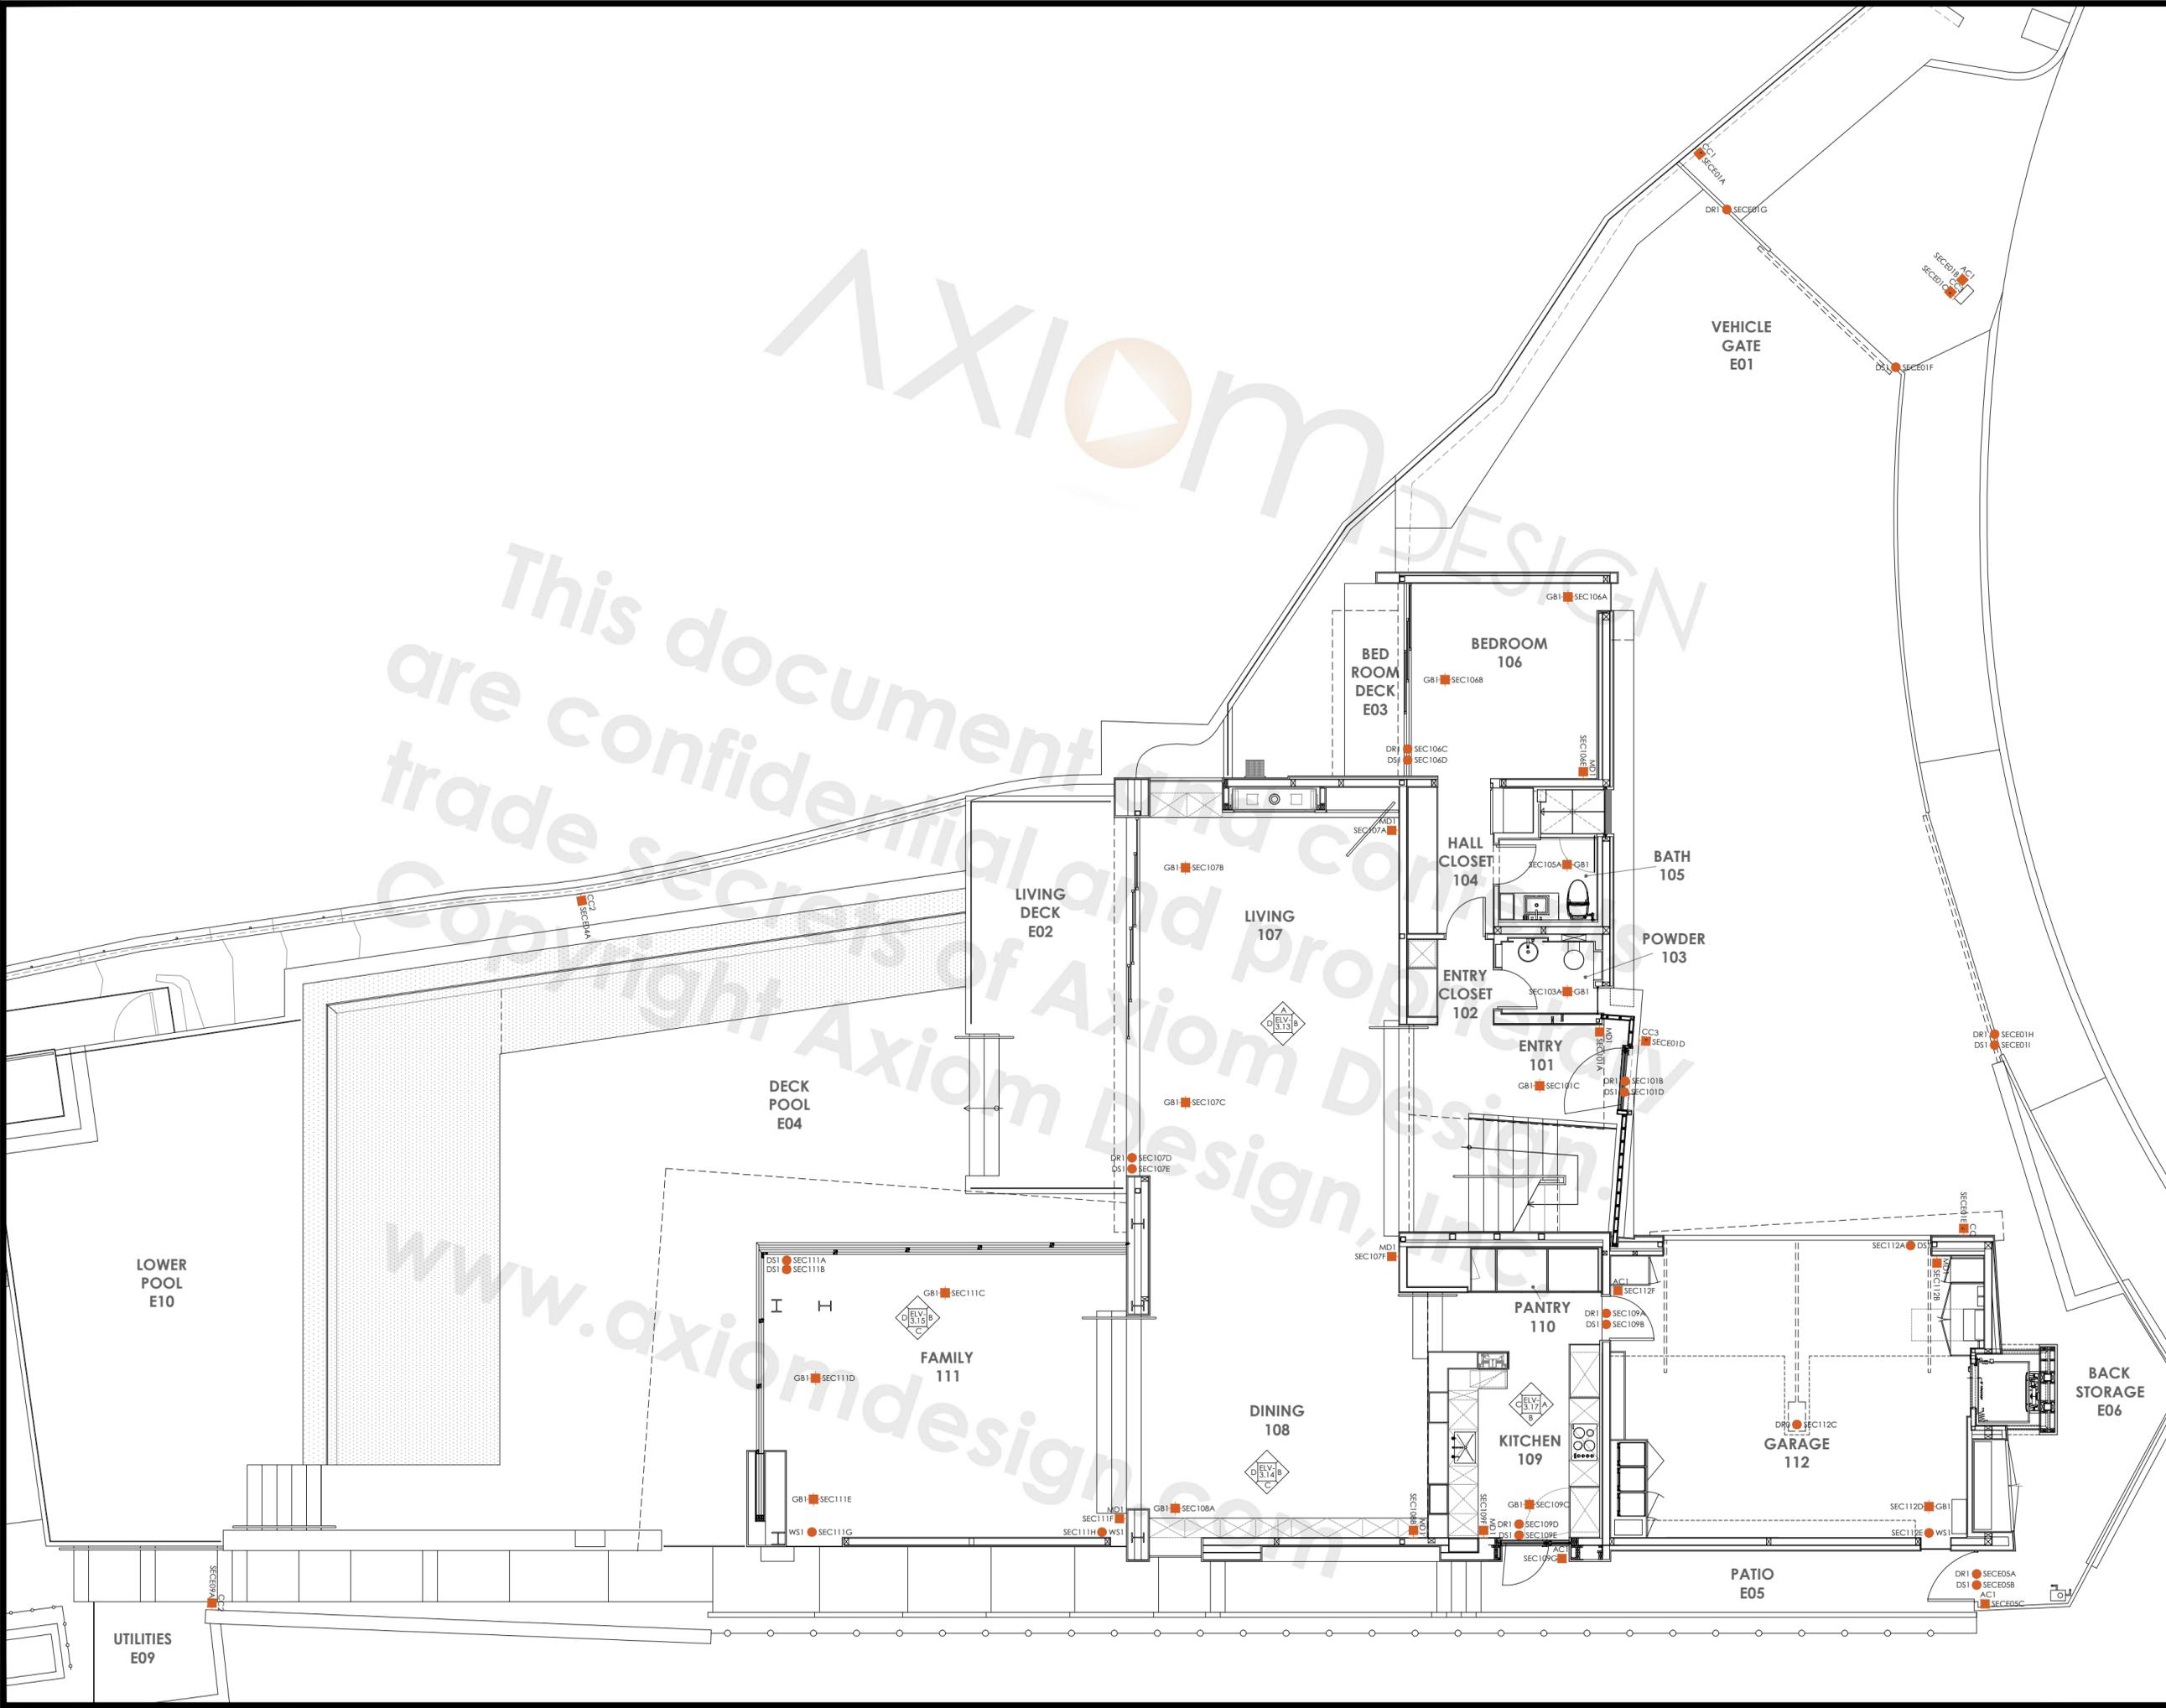
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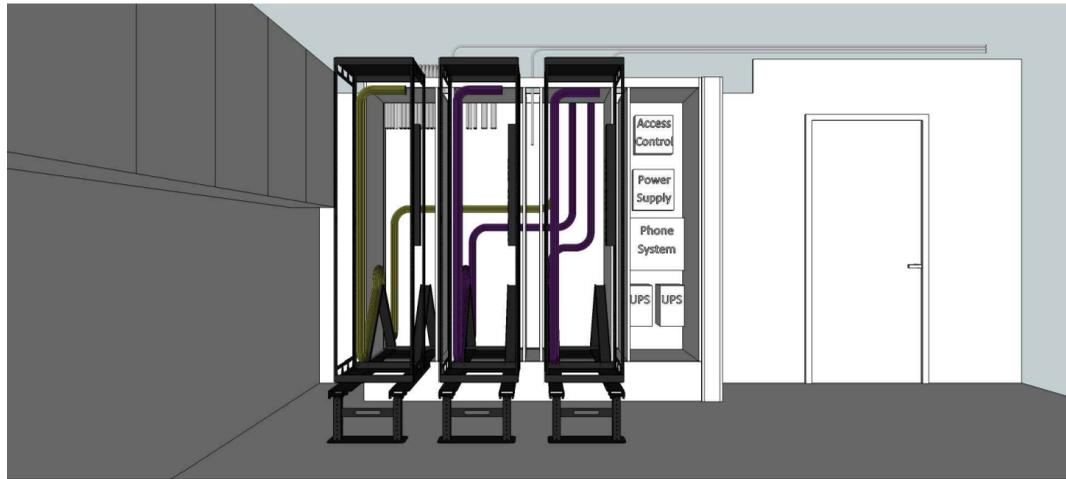
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GENERAL DEVICE LAYOUT PLAN  
FIRST FLOOR SECURITY

REVISIONS	BY


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**ELV-2.10S**







A FRONT VIEW

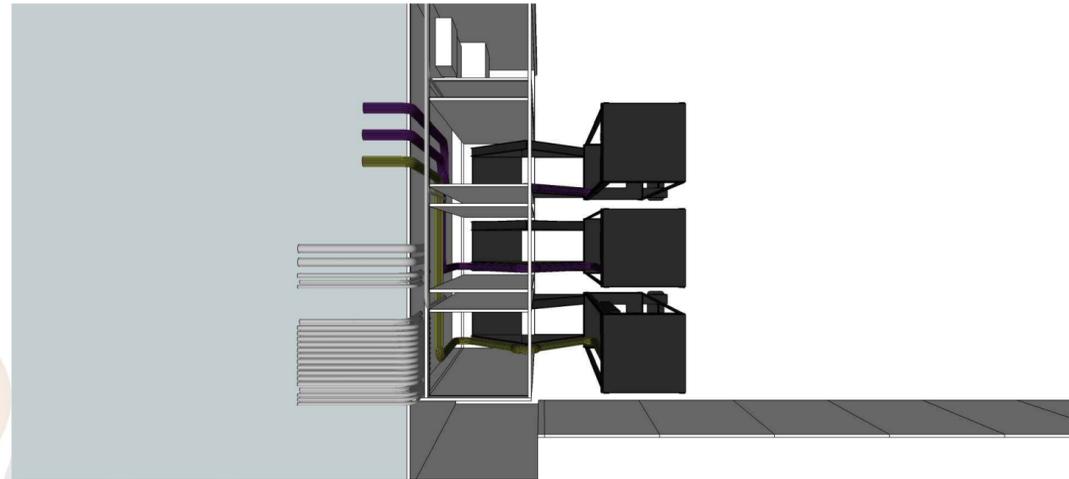


B TOP VIEW (SEE THROUGH PANELS)

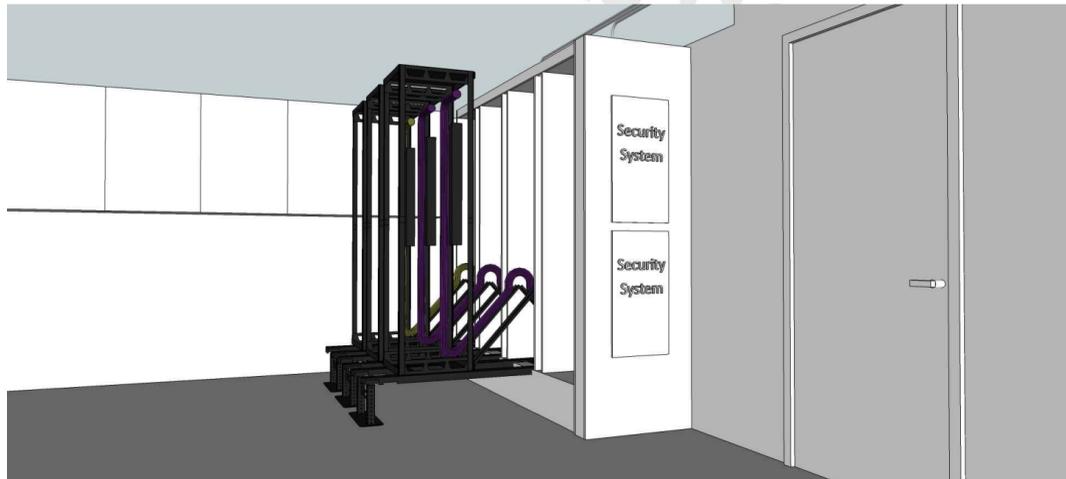

C SIDE VIEW

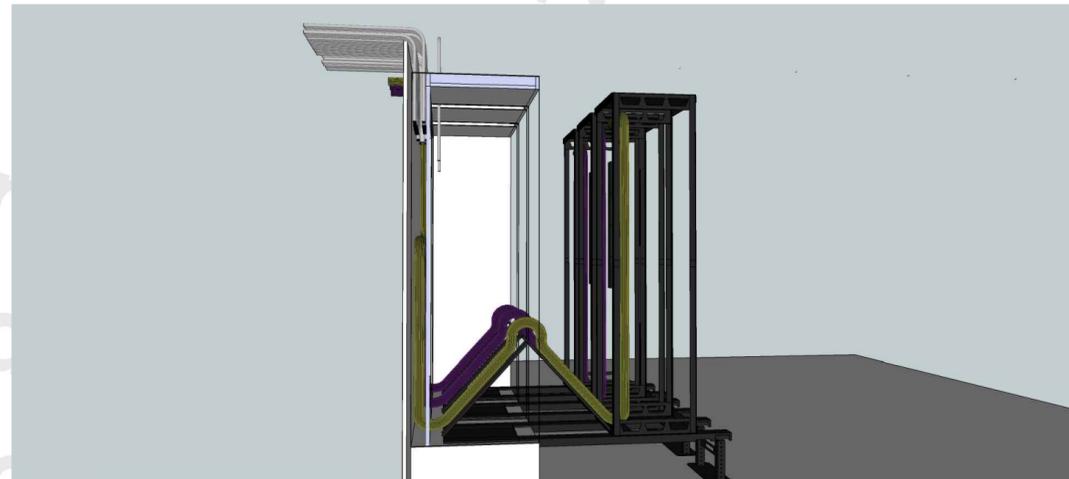

D SIDE VIEW (SEE THROUGH PANELS)

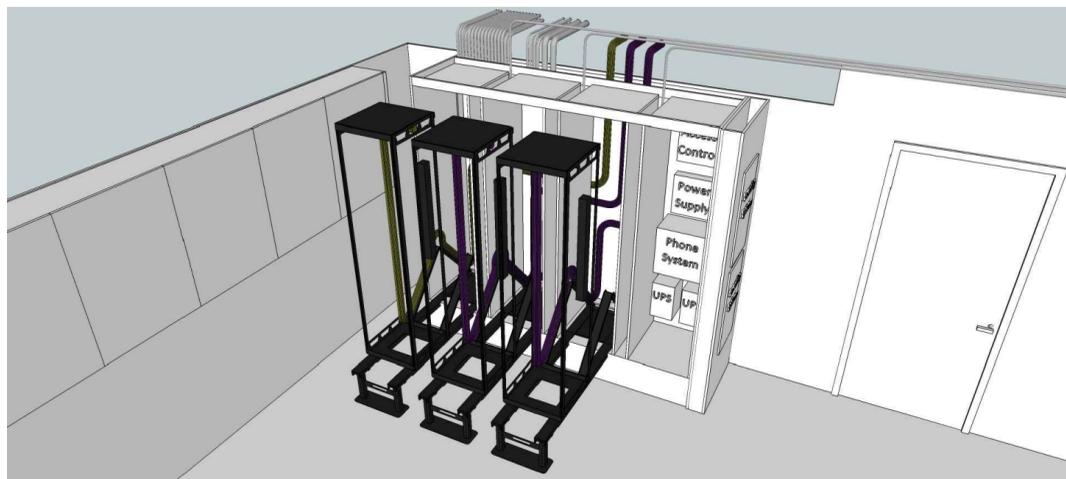

E TOP CORNER VIEW



F REAR VIEW (SEE THROUGH PANELS)

SHEET NAME:  
CONCEPTUAL LAYOUT PLAN  
MAIN DISTRIBUTION FRAME

REVISIONS	BY

DATE: 00-00-00  
SCALE: N.T.S.  
DESIGNER: DESIGNER  
DRAWN: DRAWNBY  
SHEET: